
PROPOSED SITE DEVELOPMENT AT THE

TIBER RESERVOIR MARINA WATERCRAFT INSPECTION STATION

TIBER RESERVOIR, LIBERTY CO., MONTANA

FWP PROJECT #7193603

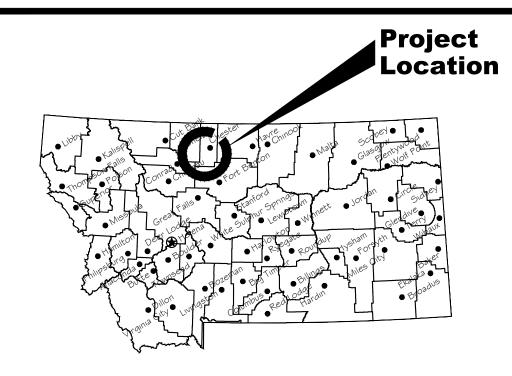

Location Map

No Scale

MONTANA FISH, WILDLIFE AND PARKS DESIGN AND CONSTRUCTION

MAILING ADDRESS: PO BOX 200701

HELENA, MT 59620-0701


PHYSICAL ADDRESS: 1522 9th AVENUE HELENA, MT 59601

TEL 406.841.4000 FAX 406.841.4004

fwp.mt.gov/Doing Business/Design&Construction





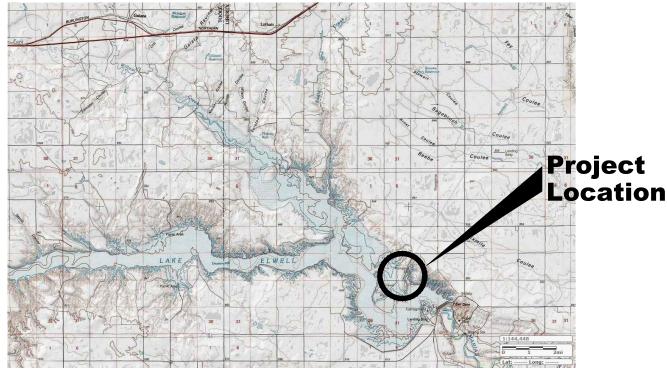


Vicinity Map

No Scale

DRAWING INDEX

- COVER SHEET
- 2 NOTES, LEGEND AND TYPICAL SECTIONS
- 3 OVERALL SITE PLAN
- CAMPGROUND ROAD PLAN AND PROFILE
- 5 INSPECTION ROAD PLAN AND PROFILE
- 6 NORTH GRADING PLAN
- 7 SOUTH GRADING PLAN
- 8 SITE LAYOUT COORDINATE TABLES

- 9 SITE LAYOUT COORDINATE TABLES
- 10 EROSION CONTROL PLAN
- 11 CAMPSITE LAYOUT DETAILS
- 12 PIPE GATE AND SIGN POST DETAILS
- 13 LATRINE INSTALLATION DETAIL
- 14 ELECTRICAL REQUIREMENTS
- 15 ELECTRICAL SITE PLAN & DETAIL
- 16 ELECTRICAL DETAILS

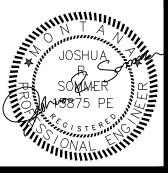

of

JWG		5/2019
DRAWN BY:	DATE:	
JRS		5/2019
CHECKED BY:	DATE:	

APPROVED BY: DATE:

APPROVED BY: DATE:

APPROVED BY: DATE:

APPROVED BY: DATE:





COVER SHEET
TIBER RES MARINA WATERCRAFT INSPECTION STATION




NOTES


- THESE NOTES ARE FOR GENERAL REFERENCE IN CONJUNCTION WITH AND AS A SUPPLEMENT TO THE WRITTEN SPECIFICATIONS, DRAWINGS, DETAILS, ADDENDA AND CHANGE ORDERS ASSOCIATED WITH THE CONTRACT DOCUMENTS, ADDITIONAL CONSTRUCTION NOTES MAY BE INCLUDED ON INDIVIDUAL DRAWINGS
- 2. THE CONTRACTOR WILL BE RESPONSIBLE FOR DEVELOPING A STORM WATER POLLUTION PREVENTION PLAN (SWPPP), AS WELL AS SUBMITTING THE NOTICE OF INTENT (NOI) AND SWPPP TO THE MONTANA DEPARTMENT OF ENVIRONMENTAL QUALITY. ASSOCIATED FEES WILL BE PAID FOR AT THE CONTRACTOR'S EXPENSE.
- 3. THE EXISTING UTILITIES ARE SHOWN AT APPROXIMATE LOCATIONS AND HAVE NOT BEEN INDEPENDENTLY VERIFIED BY THE ENGINEER. THE CONTRACTOR SHALL DETERMINE THE LOCATIONS OF ALL EXISTING UTILITIES BEFORE COMMENCING WORK. UNDERGROUND LOCATES SHALL BE MADE USING THE "ONE CALL" NUMBER 1-800-424-5555.
- 4. THE CONTRACTOR SHALL FIELD VERIFY EXISTING CONDITIONS AND EXISTING UTILITIES PRIOR TO CONSTRUCTION. IF THE SITE IS FOUND TO BE DIFFERENT THAN THE CONSTRUCTION PLANS. THE CONTRACTOR SHALL NOTIFY THE ENGINEER OF THE DISCREPANCY.
- 5. THE CONTRACTOR SHALL BE RESPONSIBLE FOR MINIMIZING TRACKING OF SOIL AND DEBRIS ONTO ADJACENT PROPERTIES AND ROADWAYS. CLEAN UP OF TRACKING DEBRIS MUST BE PERFORMED BY THE FND OF FACH DAY
- G. ANY DAMAGE SUSTAINED TO EXISTING ROADS AND PROPERTY SHALL BE RESTORED TO EXISTING CONDITION OR BETTER AT THE EXPENSE OF THE CONTRACTOR. REMEDIATION OF THE DAMAGE WILL BE ALLOWED AFTER THE MAJORITY OF HAULING ACTIVITIES HAVE BEEN COMPLETED, UNLESS OTHERWISE DIRECTED BY THE ENGINEER. IF THE DAMAGE POSES A SAFETY RISK, IT SHALL BE REPAIRED IMMEDIATELY.
- 7. THE CONTRACTOR SHALL INSTALL AND MAINTAIN ALL EROSION CONTROL ELEMENTS AND BEST MANAGEMENT PRACTICES IN ACCORDANCE WITH THE APPROVED SWPPP.
- 8. CONTRACTOR SHALL INSPECT EROSION CONTROL ELEMENTS IN ACCORDANCE WITH THE REQUIREMENTS OF THE NOTICE OF INTENT (NOI) AND THE SWPPP.
- CONTRACTOR SHALL REMOVE VEGETATION AS NECESSARY, UNLESS OTHERWISE INDICATED, WITHIN THE CONSTRUCTION AREA TO COMPLETE THE PROPOSED ACTIVITIES. ALL REFUSE MATERIAL SHALL BE HAULED OFF SITE AND DISPOSED OF IN AN ACCEPTABLE MANNER.
- IO. CONTRACTOR IS RESPONSIBLE FOR ACHIEVING PASSING QUALITY CONTROL TESTS IN ACCORDANCE WITH THE SPECIFICATIONS. THE WORK WILL NOT BE ACCEPTED UNTIL THE PASSING QUALITY CONTROL TEST RESULTS ARE RECEIVED AND APPROVED BY THE ENGINEER.
- II. THE CONTRACTOR IS RESPONSIBLE FOR ALL REPAIRS TO SURFACING (GRAVEL, SEEDING, ETC.) THAT IS DAMAGED AS A RESULT OF CONSTRUCTION ACTIVITIES. REPAIRS OUTSIDE OF THE IMMEDIATE PROJECT CORRIDOR, INCLUDING SURFACING REPAIR ON HAUL ROUTES WILL BE MADE BY THE CONTRACTOR AT NO ADDITIONAL COST

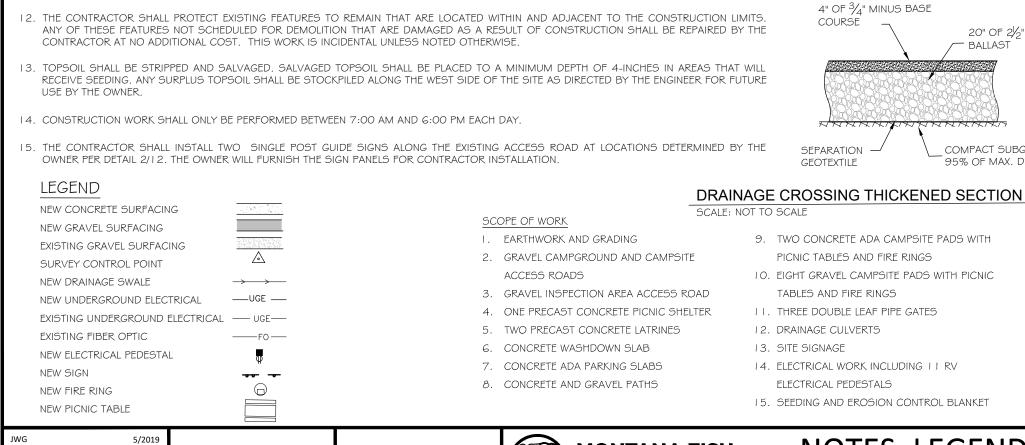

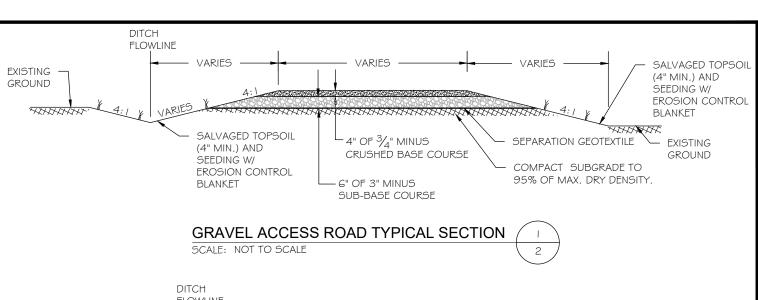


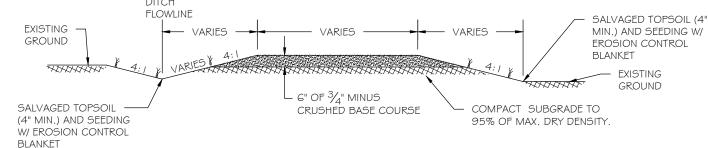



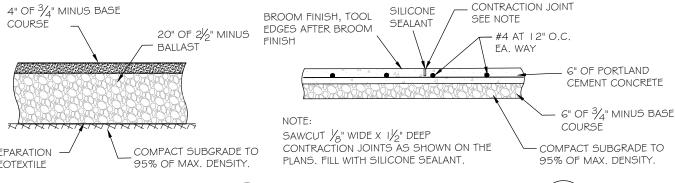



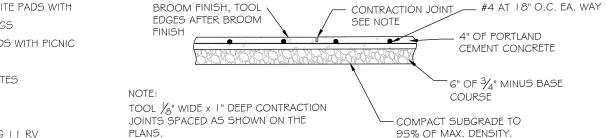

4" CONCRETE SECTION (ADA CAMPSITE PADS AND PATHS)

SCALE: NOT TO SCALE

JWG		5/2019
DRAWN BY:	DATE:	
JRS		5/2019
CHECKED BY:	DATE:	


APPROVED BY: DATE: APPROVED BY: DATE: APPROVED BY: DATE: APPROVED BY: DATE:





NOTES, LEGEND AND TYP. SECTIONS TIBER RES MARINA WATERCRAFT INSPECTION STATION





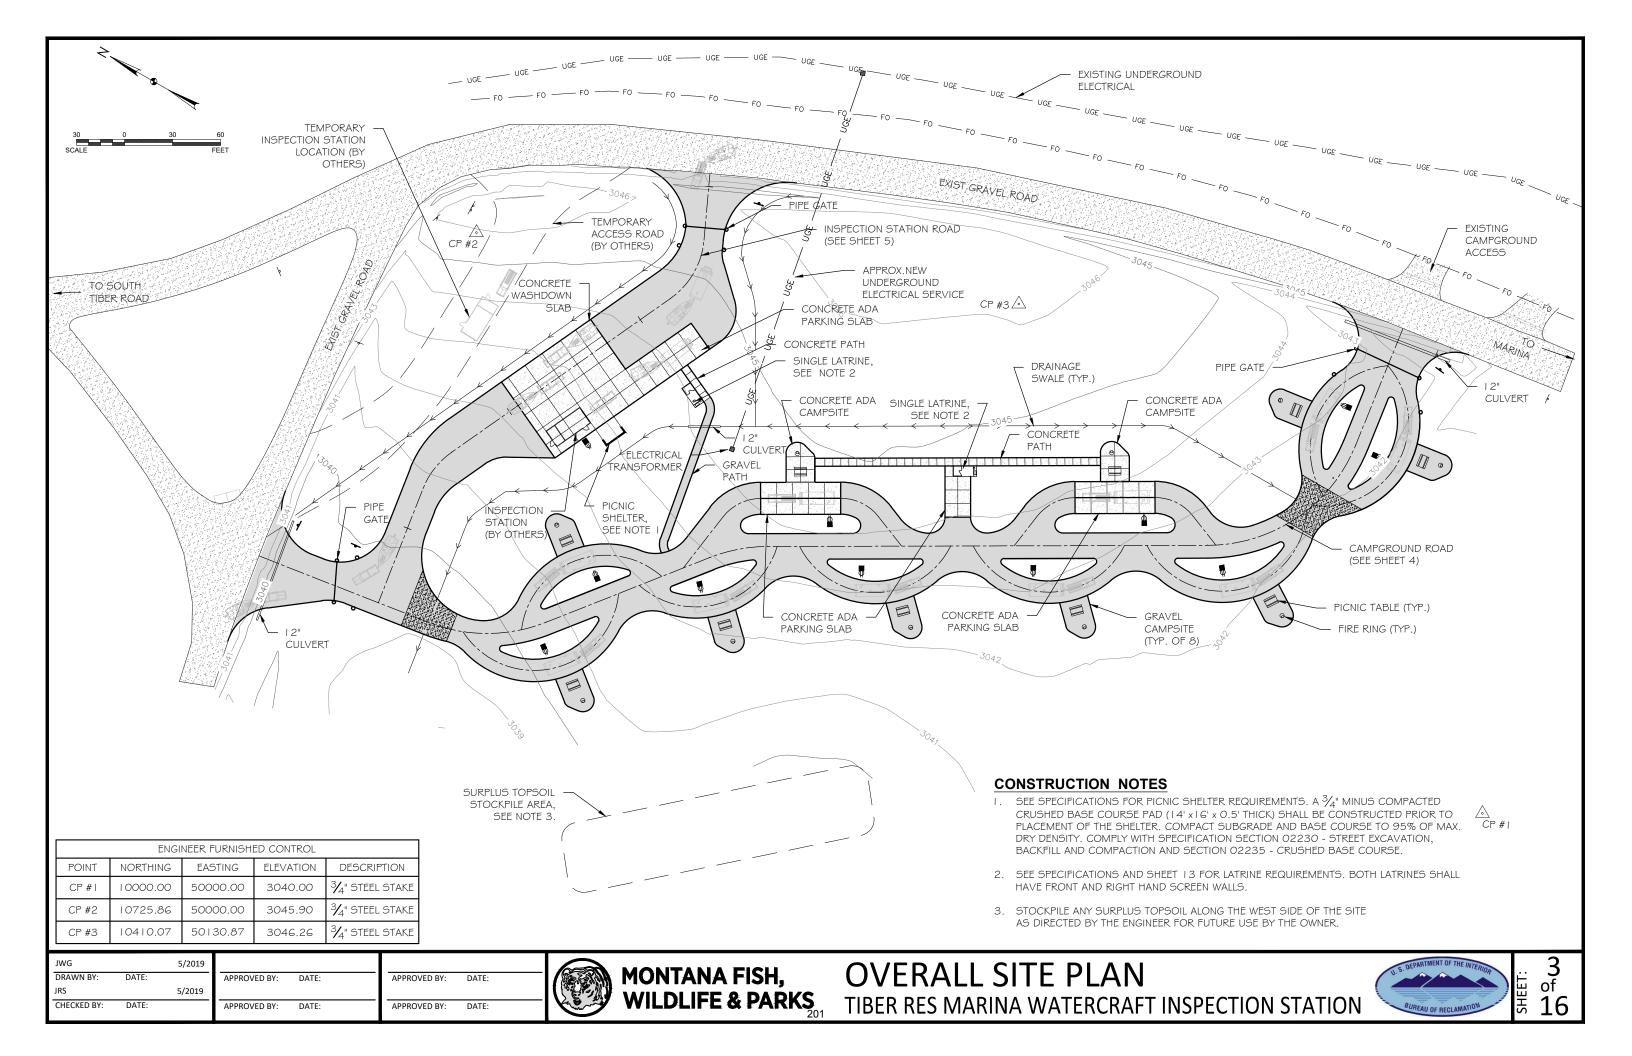

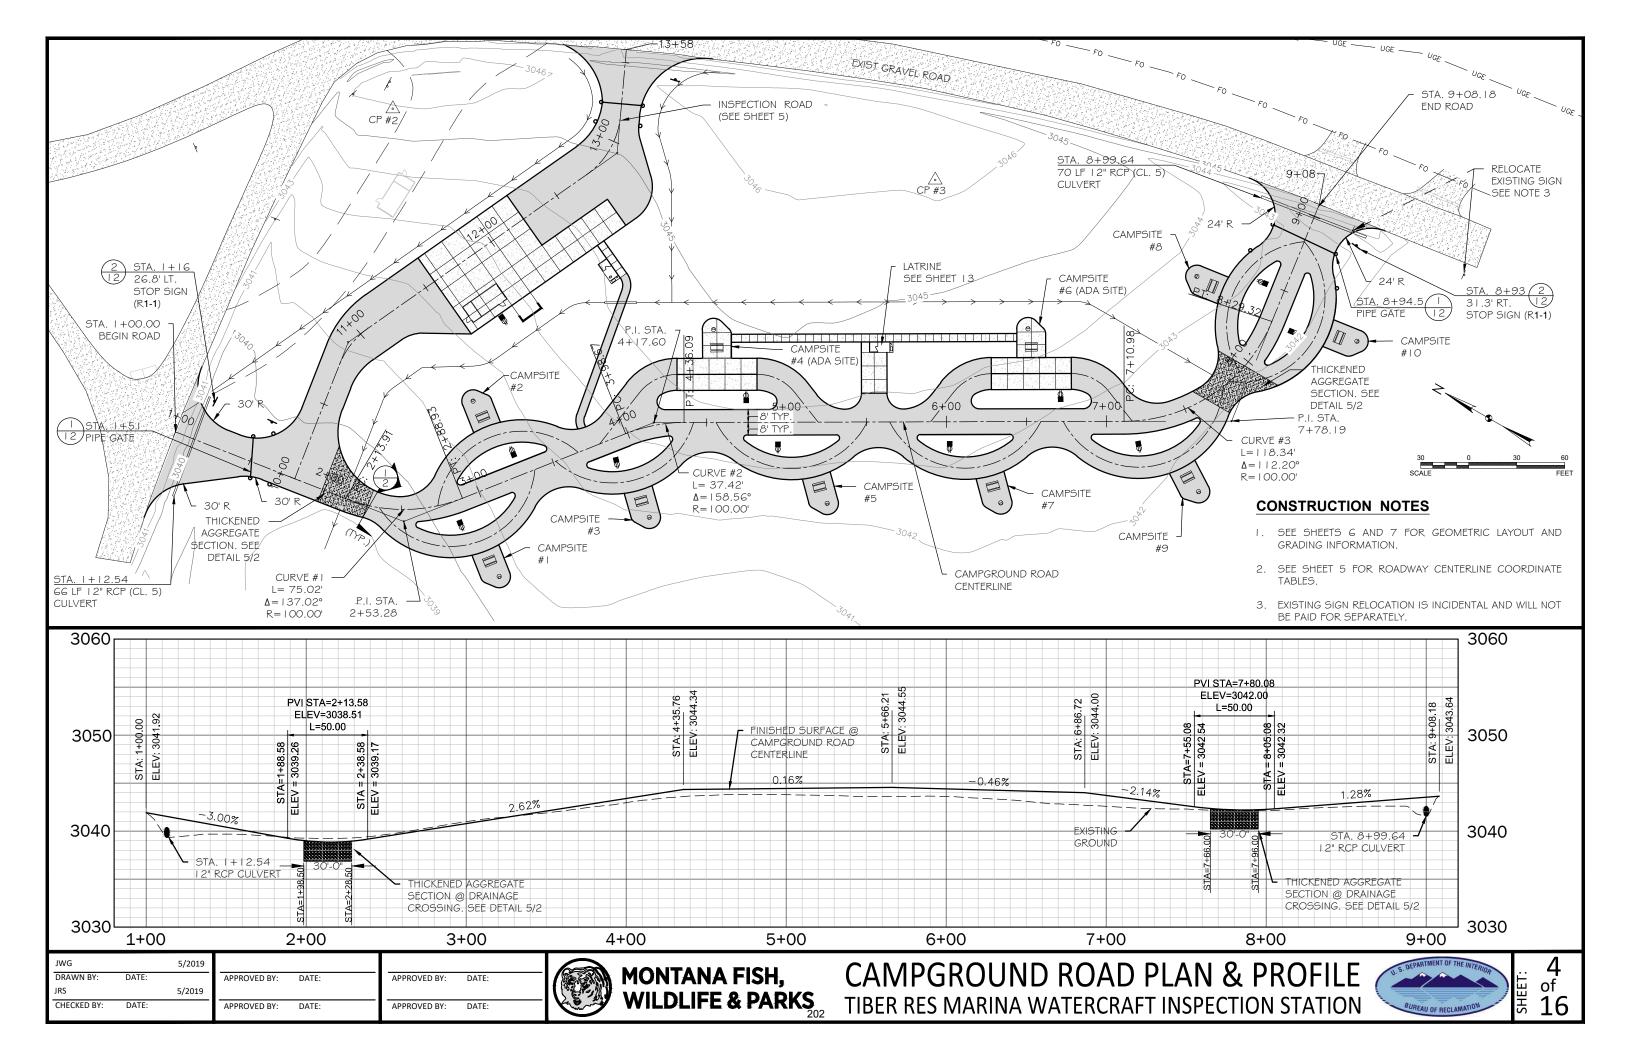

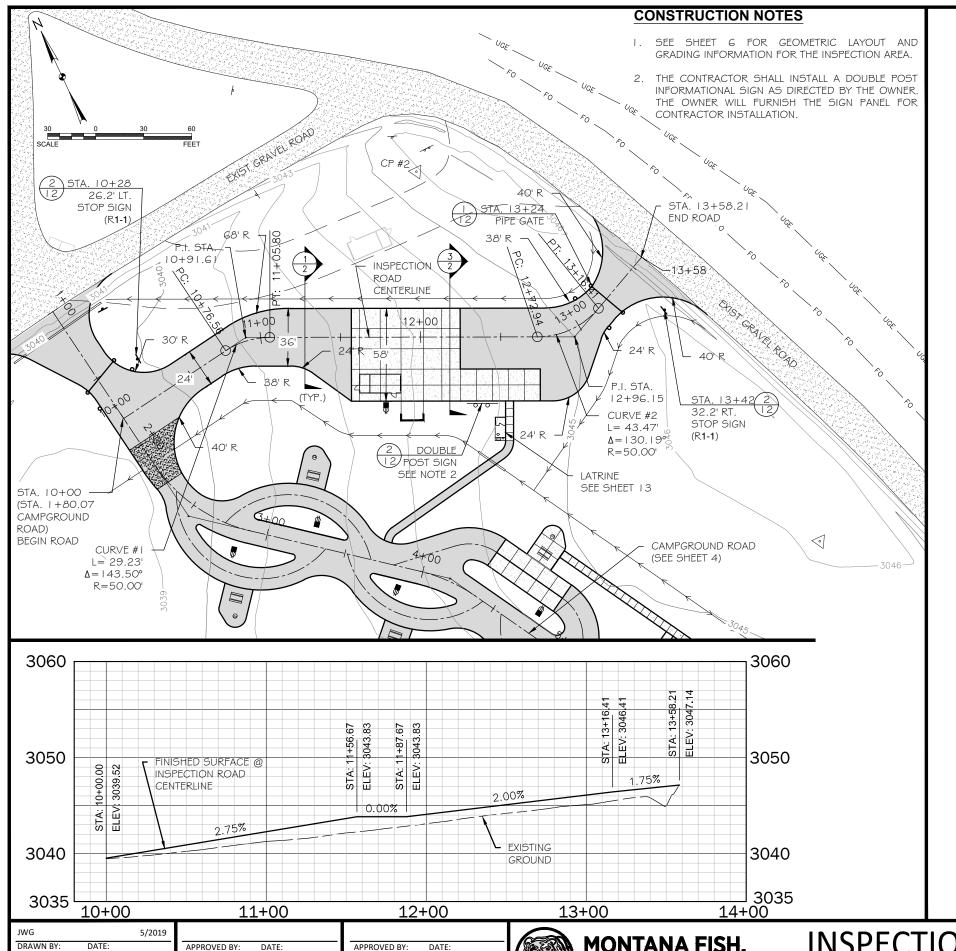

5/2019

APPROVED BY: DATE:

APPROVED BY:

DATE:

CHECKED BY:

CAMPGROUND ROAD CENTERLINE COORDINATE TABLE				
STATION	NORTHING	EASTING	REMARKS	
1+00.00	10742.60	49757.13	BEGIN ROAD	
2+13.91	10629.97	49774.16	PC	
2+53.28	10591.04	49780.04	CURVE #1 PI	
2+88.93	10566.57	49810.89	PT	
3+98.67	10498.39	49896.88	PC	
4+17.60	10486.62	49911.71	CURVE #2 PI	
4+36.09	10470.25	49921.21	PT	
7+10.98	10232.53	50059.26	PC	
7+78.19	10174.41	50093.00	CURVE #3 PI	
8+29.32	10183.70	50159.56	PT	
9+08.18	10194.60	50237.65	END ROAD	

INSPECTION ROAD CENTERLINE COORDINATE TABLE				
STATION	NORTHING	EASTING	REMARKS	
10+00.00	10663.43	49769.10	BEGIN ROAD	
10+76.56	10674.87	49844.80	PC	
10+91.61	10677.12	49859.68	CURVE #1 PI	
11+05.80	10670.79	49873.33	PT	
12+72.94	10600.41	50024.93	PC	
12+96.15	10590.64	50045.99	CURVE #2 PI	
13+16.41	10600.41	50067.05	PT	
13+58.21	10618.02	50104.96	END ROAD	



INSPECTION ROAD PLAN & PROFILE TIBER RES MARINA WATERCRAFT INSPECTION STATION



